NOTES:

1. IN ACCORDANCE WITH "CODES OF PRACTICE FOR MINIMUM FIRE SERVICE INSTALLATIONS AND EQUIPMENT", CLAUSE 4.14. THE PROVISION OF HOSE REEL SYSTEM, FIRE ALARM SYSTEM, EMERGENCY LIGHTING, EXIT SIGN, PORTABLE HAND OPERATED FIRE FIGHTING EQUIPMENT AND SECONDARY SOURCE OF ELECTRICAL, SUPPLY SHALL BE PROVIDED FOR THE PROPOSED TEMPORARY SHOP AND SERVICES.

2. THE AGGREGATE AREA OF PROPOSED STRUCTURE DOES NOT EXCEED 230M. THUS, AN AUTOMATIC SPRINKLER SYSTEM SHOULD NOT BE INSTALLED.

3. HOSE REELS REFER TO CLAUSE 5.14(b) IN THE CODE PRACTICE FOR MINIMUM FIRE SERVICE INSTALLATION AND EQUIPMENT APRIL 2012. 읶

H.R. SYSTEM

1. ON-OFF TYPE HOSE REEL NOZZLES HOUSED IN GLASS-FRONTED CABINETS WITH PADLOCKS SHALL I INSTALLED AT LOCATION NOT HIGHER THAN 1350 AF) 사람.

HOSE REEL INSTRUCTION PLANS SHALL BE PROVIDED L HOSE REELS. FOR

THE LENGTH OR RUBBER HOSES SHALL NOT BE MORE THAN

위照5 PROVIDED MANUAL FIRE ALARM CONTROL PANE SHOULD PROVIDED AS INDICATED ON G/F FOR FIRE ALARM THE HOSE REEL SYSTEM. DUTY AND STANDBY FIXED FIRE PUMPS OVIDED FOR THE HOSE REEL SYSTEM. SHOULD

SIGNALS

6. THE HOSE REEL BRANCH NOZZLE SHALL HAVE A 4.5mm ORIFICE AND BE FITTED WITH A SIMPLE TWO WAY VALVE TO OPEN OR SHUT OFF JET. THE VALVE MUST NOT BE SPRING LOADED

7. ALL FIRE SERVICE INSTALLATIONS SHOULD FULLY COMPLY WITH THE CURRENT REQUIREMENTS OF THE FIRE SERVICES DEPARTMENT AND THE WATER SUPPLIES DEPARTMENT.

8. HOSE REELS REFER TO CLAUSE 5.14(b) IN THE CODE PRACTICE FOR MINIMUM FIRE SERVICE INSTALLATION AND EQUIPMENT APRIL 2012. 유

9. ELECTRICAL CABLES FOR SERVICES PUMPS SHALL BE WITH BS6387 CAT CWZ. FIRE ALARM BELLS AND FIRE FIRE RESISTING TYPE COMPLYING

10. A NEW FIBERGLASS STORAGE CAPACITY NOT PROVIDED ON G/F FOR F.S. V LESS HOSE WATER SE REEL TANK OF EFFECTIVE 2000 LITERS SHALL L SYSTEM. 먪

EMERGENCY LIGHT (WALL MOUNT)

 \overline{A}

공동

CO2 PORTABLE EXTINGUISHER

FIRE ALARM SYSTEM

START BELLS ACTUATION OF ANY BREAKGLASS UNIT IN THE BUILDING WILL IART THE FIXED FIRE PUMP AND SOUND ALL THE ALARM ELLS IN THE WHOLE BUILDING.

2. THE CAPACITY OF BATTERY IS SUFFICIENT TO MAINTAIN THE SYSTEM IN NORMAL CONDITION FOR 24 HOURS (A.F.A. SYSTEM) AND IT SHALL BE ABLE TO OPERATE THE SYSTEM AT ALARM CONDITION FOR 30 MINUTES.

 \rtimes

____FLASHING LIGHT

OTHERS

1. ALL EXITS AND EXIT ROUTES SHALL COMPLY WITH CODE OF PRACTICE & FSD C.L. 5/08 AND TO BE CLEARLY INDICATED BY ILLUMINATED "EXIT" "HID" SIGN AND DIRECTIONAL SIGNS IN CHINESE AND ENGLISH CHARACTERS OF NOT LESS THAN 125MM HIGH W/. 15MM WIDE STROKES.

2. EMERGENCY LIGHTING SHALL COMPLY WITH BS EN 1838/1999 AND TO BE PROVIDED THROUGHOUT THE ENTIRE BUILDING AND SHALL COMPLY WITH BS 5266; PART 1 AND EN 1838 EXCEPT THAT OF EXIT SIGNS. BS

APPLICATION SIT

POST FRUNC

SHUI KILD

<u> ABBREV</u>	ABBREVIATIONS	LEGENDS	100	222 A	CASTLE
F/A	FROM ABOVE	ى (<u>ا</u>	FIRE HOSE REEL		
F/B	FROM BELOW		MFA CALL POINT UNIT	HS.	
A/1	TO ABOVE)		.0	と
i .	1	Ð	FIRE ALARM BELL		
1/8	TO BELOW	MFAP	MFA CONTROL PANEL	,)	Bell
>	LOW LEVEL		FIXED FIRE PUMP		
\ \ \	MIDDLE LEVEL		CONTROL PANEL	Г	
Ż	HIGH LEVEL	FSPA	FIXED FIRE PUMP SETS ARRANGEMENT		
AFFL.	ABOVE FINISHED FLOOR LEVEL		FIXED FIRE PUMP		
S.	FIRE SERVICES	X	GATE VALVE		
方	FIRE HOSE REEL	Ζ	CHECK VALVE		
.н.	ACCESS MANHOLE	8	BALL FLOAT VALVE		
/.P.	VENT PIPE	-	AUTOMATIC AIR VENT	® ₽	Test valve
O.F.	OVERFLOW PIPE	Ó	CHECK METER POSITION	00	Check val
ΛFA	MANUAL FIRE ALARM	Ū	PRESSURE SWITCH ASSEMBLY	Ô	Pressure standby f changeove
		EXIT	EXIT SIGN		7

	ø40	ø25	PIPE SIZE	COLOUR
	PURPLE	GREEN	COLOUR	CODE FOR
9.5	_			PIPE

ģ

changeover (No flow) standby fixed fire pu Pressure switch Pressure gauge Check valve Union

lest valve (normal c/w ø3mm

9. c

PRESSURE

Project: F.S. LAYOUT PLAN OF PROPOSED TEMPORARY SHOP AND SERVICE (REAL ESTATE AGENCY) AT LOT 30 RP IN D.D124, SUN FUNG WAI, TUEN MUN, N.T.


F.S. NOTES, ABBREVIATIONS, LEGENDS, BLOCK PLAN, COLOUR CODE FOR PIPE SIZE AND PRESSURE SWITCH ASSEBILY


Si Contractor:		
基業消	防工程	有限公司

BLOCK PLAN (NTS

KEI YIP FIRE ENGINEERING LTD Rm. 727A , Block 1, W Cheung Sha Wan, Kin. Tel.: (852) 2387 8772 Wang Cheong Factory Estate, Email: yuenfatcoGyahoo.com.hk Fox: (852) 2748 0011

Rev	Dwg. No. FS-01	Dwg. Date: 17-NOV-2015	Cod Ref: PTS/FS/DWG-01	
	Drawn: Checked: CAD		Scale: NTS	
	ı e	DESCRIPTION	DES	
4	AS PER PLANNING DEPARTMENT COMMENT 30/3/2017			4/2017
5	D	1/2018 AS-FITTED		11/2018

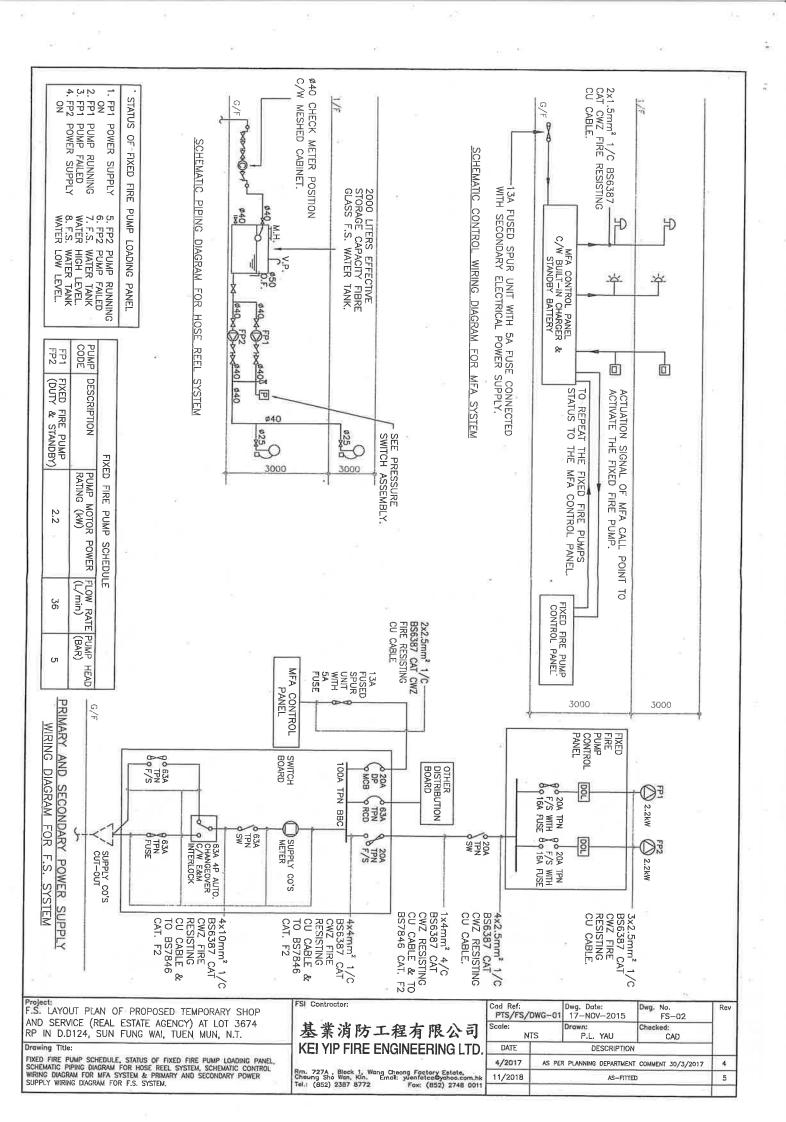

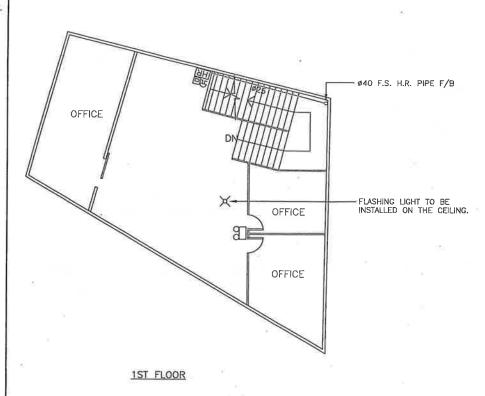

#40 CHECK METER POSITION C/W
METAL MESH BOX & LOCK FOR
FIRE HOSE REEL SYSTEM.

#40 WATER SUPPLY PIPE (CONNECTED FROM UNDERGROUND GOVERNMENT TOWN MAIN WATER SUPPLY).

OFFICE

OFFICE

SITTING AREA

OFFICE

SITTING OB

SITTING AREA

OFFICE

SITTING AREA

OFFICE

SITTING OB

SITTING AREA

OFFICE

SITTING OB

SITTING AREA

OFFICE

SITTING OB

SITTING OB

SITTING OB

SITTING AREA

OFFICE

SITTING OB

PACIFIC AND ADMINISTRATION OF THE PACIFI
RP IN D.D124, SUN FUNG WAI, TUEN MUN, N.T.
AND SERVICE (REAL ESTATE AGENCY) AT LOT 3674
F.S. LAYOUT PLAN OF PROPOSED TEMPORARY SHOP
Project

Drawing Title: F.S. FLOOR LAYOUT PLAN OF GROUND FLOOR AND FIRST FLOOR, FIXED FIRE PUMP SETS ARRANGEMENT & CHECK METER POSITION 131 Contiductor

基業消防工程有限公司 KEI YIP FIRE ENGINEERING LTD.

Rm. 727A , Block 1, Wang Cheong Factory Estate, Cheung Sha Wan, Kin. Email: yuenfatco yaroo.com.hk Tel.: (852) 2387 8772 Fax: (852) 2748 0011

	10 20			2.50	
	Cad Ref: PTS/FS/DWG-01 Scale: 1 : 100@A3		Dwg. Date: 17-NOV-2015	Dwg. No. FS-03	Rev
			Drawn: P.L. YAU	Checked: CAD	
).	DATE		DESCRIPTIO	N	
	4/2017	AS PE	R PLANNING DEPARTMEN	NT COMMENT 30/3/2017	4
nk	11/2018	AS-FITTED			5
11					